
KEY NOTES

EXISTING FIRE ALARM CONTROL PANEL SIMPLEX 4100U SHALL REMAIN.
ALL NEW DEVICES SHALL CIRCUITED TO EXISTING PANEL. MODIFY
PANEL AS REQUIRED TO ACCOMMODATE NEW CONNECTIONS. REFER

GENERAL NOTES

- A. COORDINATE LOCATION AND MOUNTING HEIGHT OF ELECTRICAL DEVICES IN CRAWLSPACE WITH ALL DISCIPLINES AND TRADES PRIOR TO INSTALLATION.
- B. INSTALL CONDUIT WITH NO MORE THAN TWO (2) 90° BENDS BETWEEN PULL BOXES, AND NO MORE THAN 100'-0" (30m) / 30m (100'-0") BETWEEN PULL BOXES. PULL BOXES SHALL BE INSTALLED FOR STRAIGHT THRU PULLS ONLY.
- C. ALL WIRINGS SHALL BE IN CONDUIT.
- D. FIRE ALARM HORN/STROBE SHALL BE MOUNTED ON WALL OF 2ND FLOOR LANDING ONLY. REFER TO RISER DIAGRAM E5.4.
- FIRE ALARM DETECTOR SHALL BE MOUNTED ON CEILING OF 3RD FLOOR LANDING ONLY. REFER TO DETAILS.
- ELECTRICAL CONTRACTOR SHALL COORDINATE QUANTITIES AND LOCATIONS OF ALL SWITCHES AND VALVES REQUIRING WIRING WITH SPRINKLER CONTRACTOR.

 REFER TO FIRE ALARM RISER AND ZONE SCHEDULE FOR INITIATING ZONES AND SIGNAL
- PROVIDE REVERIFICATION OF FIRE ALARM SYSTEM FOR ALL NEW AND MODIFIED
- I. HEAT DETECTORS WITHIN CRAWLSPACE SHALL BE NON-ADDRESSABLE MOISTURE

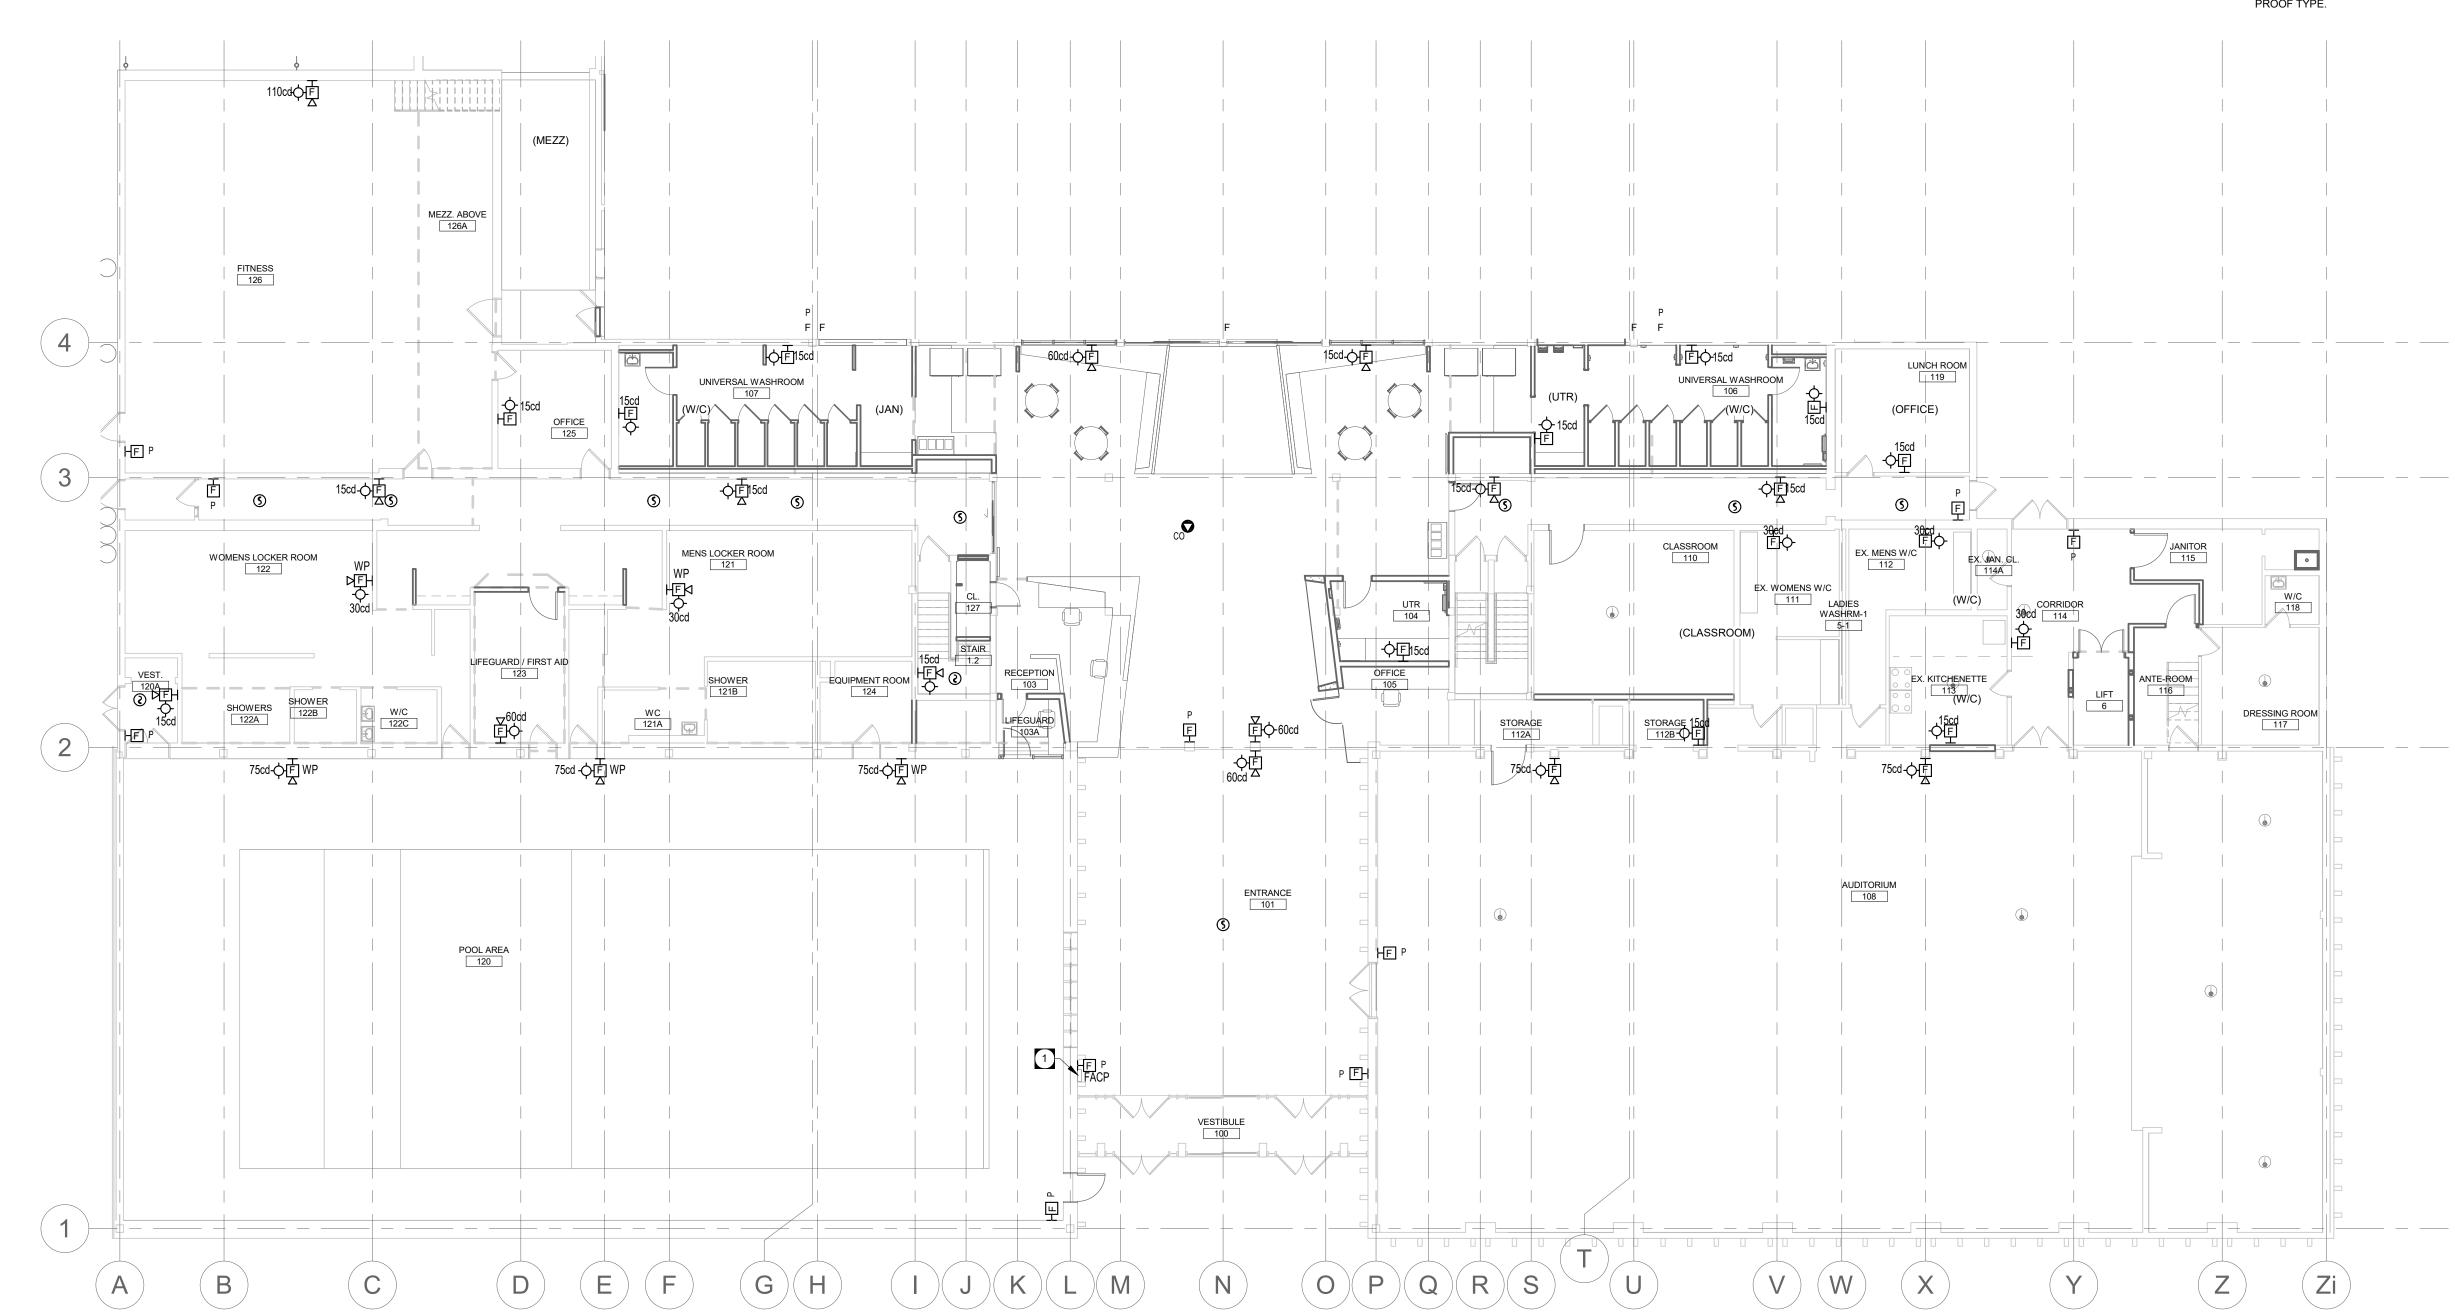

LEVEL 1 - FIRE ALARM RENOVATION 1

3/32" = 1'-0" EF2.1



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Rev. No. Date Revision Notes


0 19-11-06 Issued for Construction



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This drawing must not be scaled. The contractors shall verify all dimensions and other data on site prior to commencement of work. Discrepancies, errors, and omissions are to be reported to Public City Architecture Inc. prior to proceeding with the Work.

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Project

ST. JAMES CIVIC CENTRE

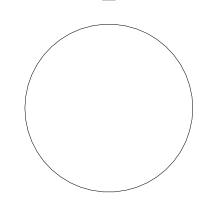Orawing

LEVEL 1 RENOVATION FIRE ALARM PLAN

Drawn By: Review By:

JA MP

Scale: Tender No:
As indicated 1176-2019

Date: 11/06/19

FF2 1